212
 1
 2' - 8"
 8' - 0"

 213
 1
 6' - 0"
 8' - 0"

214 1 3' - 0" 8' - 0"

FLOOR PLAN **GENERAL NOTES:**

 GAS PIPING PLACED UNDER ANY CONCRETE SLAB SHALL COMPLY PER UPC 1210.1.6. REQUIREMENTS. SHALL CONFORM TO U.P.C. CHAPTER 12 FOR MATERIALS, INSTALLATION, AND TESTING.

2. RANGES AND COOKTOPS: Provide a listed and approved range and/or cooktop unit installed in accordance with the listing and with the manufacturer's installation instructions.

VERTICAL CLEARANCES ABOVE THE FINISHED COUNTERTOP SURFACE BEFORE ORDERING OR INSTALLING CABINETS.

3. VERIFY AND MAINTAIN REQUIRED HORIZONTAL AND


4. MAXIMUM STUD SPACING IS 16 INCHES ON CENTER UNLESS NOTED OTHERWISE

5. REFER TO STRUCTURAL DRAWINGS FOR LOCATIONS AND ADDITIONAL REQUIREMENTS FOR LOAD-BEARING AND SHEAR WALLS

6. TYPICAL GYPSUM SHEATHING THICKNESS IS 5/8 INCH UNLESS NOTED OTHERWISE

7. SEE DETAIL 9 ON A110 FOR STUCCO SYSTEM ASSEMBLY

FLOOR PLAN LEGEND

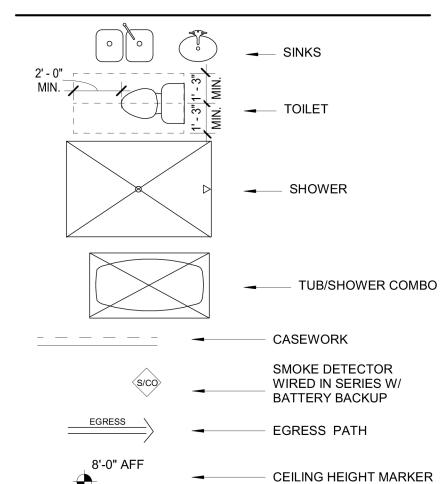

2"X4" INTERIOR WOOD STUD WALL

STUD WALL

- 2"X6" INTERIOR WOOD

PER UL NO. U305

- 2"X6" INTERIOR WOOD STUD WALL W/ 1 HR FIRE PARITION

2"X6" EXTERIOR WOOD STUD WALL ALL WOOD FRAMED EXTERIOR WALLS TO HAVE AIR IMPERMEABLE SPRAY FOAM INSULATION R-21 MIN. TYP.

ALL CEILINGS TO HAVE AIR

IMPERMEABLE SPRAY FOAM INSULATIONR-38 MIN. TYP.

90% OF LAMPS IN PERMANENT FIXTURES OR 90% OF PERMANENT FIXTURES HAVE HIGH EFFICACY LAMPS. DOES NOT APPLY TO LOW **VOLTAGE LIGHTING**

KEYNOTES

1 PROVIDE TILE SURFACE AT WALLS SHOWN WITH BOLD DASHED LINE PER IRC R708.2. TILE SURFACE SHALL EXTEND A MINIMUM OF 6 FEET ABOVE FINISHED FLOOR HEIGHT 2 PROVIDE 1-RATED WALL ASSEMBLY AS MOTED REFER TO RATED WALL ASSEMBLY ∕∱(DETĄIL 9 ON SHEET A502. 3 OVERHANG ABOVE OF FLOOR/ROOF

4 ALL WEATHER LANDING SURFACE EQUAL IN WIDTH TO THE DOOR SERVED AND MIN. 36 DEEP IN DIRECTION OF TRAVEL AT ALL EXTERIOR DOORS PER IRC R311.3 14 ROOF SCUPPER 19 TANKLESS WATER HEATER AND SOFT

WATER LOOP. TANKLESS WATER HEATER

MINIMUM CLEARANCE 6 FT ABOVE FINISH 20/36 MIN HEIGHT GAURDRAIL W/4/MÁX VERTICAL SPACING OF HORIZONTIAL RUNGS. GAURDRAIL TO SUPPORT 200# CONCENTRATED LOAD / 50# UNIFORM LOAD 21 OPEN RISERS CANNOT PERMIT THE PASSAGE OF A 4 SPHERE BETWEEN

TREADS. 22 PROFILE OF TREAD: RADIUS OF LEADING EDGE OF TREAD SHALL BE NO GREATER THAN 9/16. A NOSING NOT LESS THAN 3/4 BUT NOT MORE THAN 1 1/4 SHALL BE PROVIDED ON STAIRWAYS WITH SOLID

30 HEAT PUMP - SEE MECH.

31 TRASH/RECYCLING BINS **32** GAS METER, SEE PLUMBING **33** ELECTRICAL PANEL, SEE ELEC.

34 AIR HANDLER, SEE MECH. 35 AV RACK 20"X20" 40 ATTIC ACCESS PANEL MIN 22"X30" PER IRC

TNNK DESIGN**TANK** © 1934 E CAMELBACK ROAD, SUITE 120-411 PHOENIX, AZ 85016 503.580.5626

REVISION DATE REASON FOR ISSUE 1 02/22/2022 City Comments



FIRST FLOOR PLAN AND SCHEDULES

PERMIT SET

DATE 2021-09-28	REVISION 1
PROJECT NUMBER 00000	SHEET NUMBER
SCALE As indicated	A104

LEVEL 1

1/4" = 1'-0"


TNNK

1934 E CAMELBACK ROAD, SUITE 120-411

DESIGN**TANK** ©

503.580.5626

PHOENIX, AZ 85016

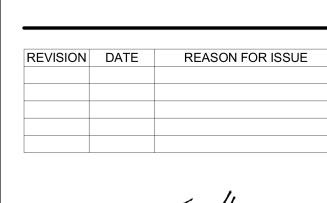




SECOND FLOOR PLAN

PERMIT SET

DATE 2021-09-28 REVISION PROJECT NUMBER 000000 SCALE
As indicated



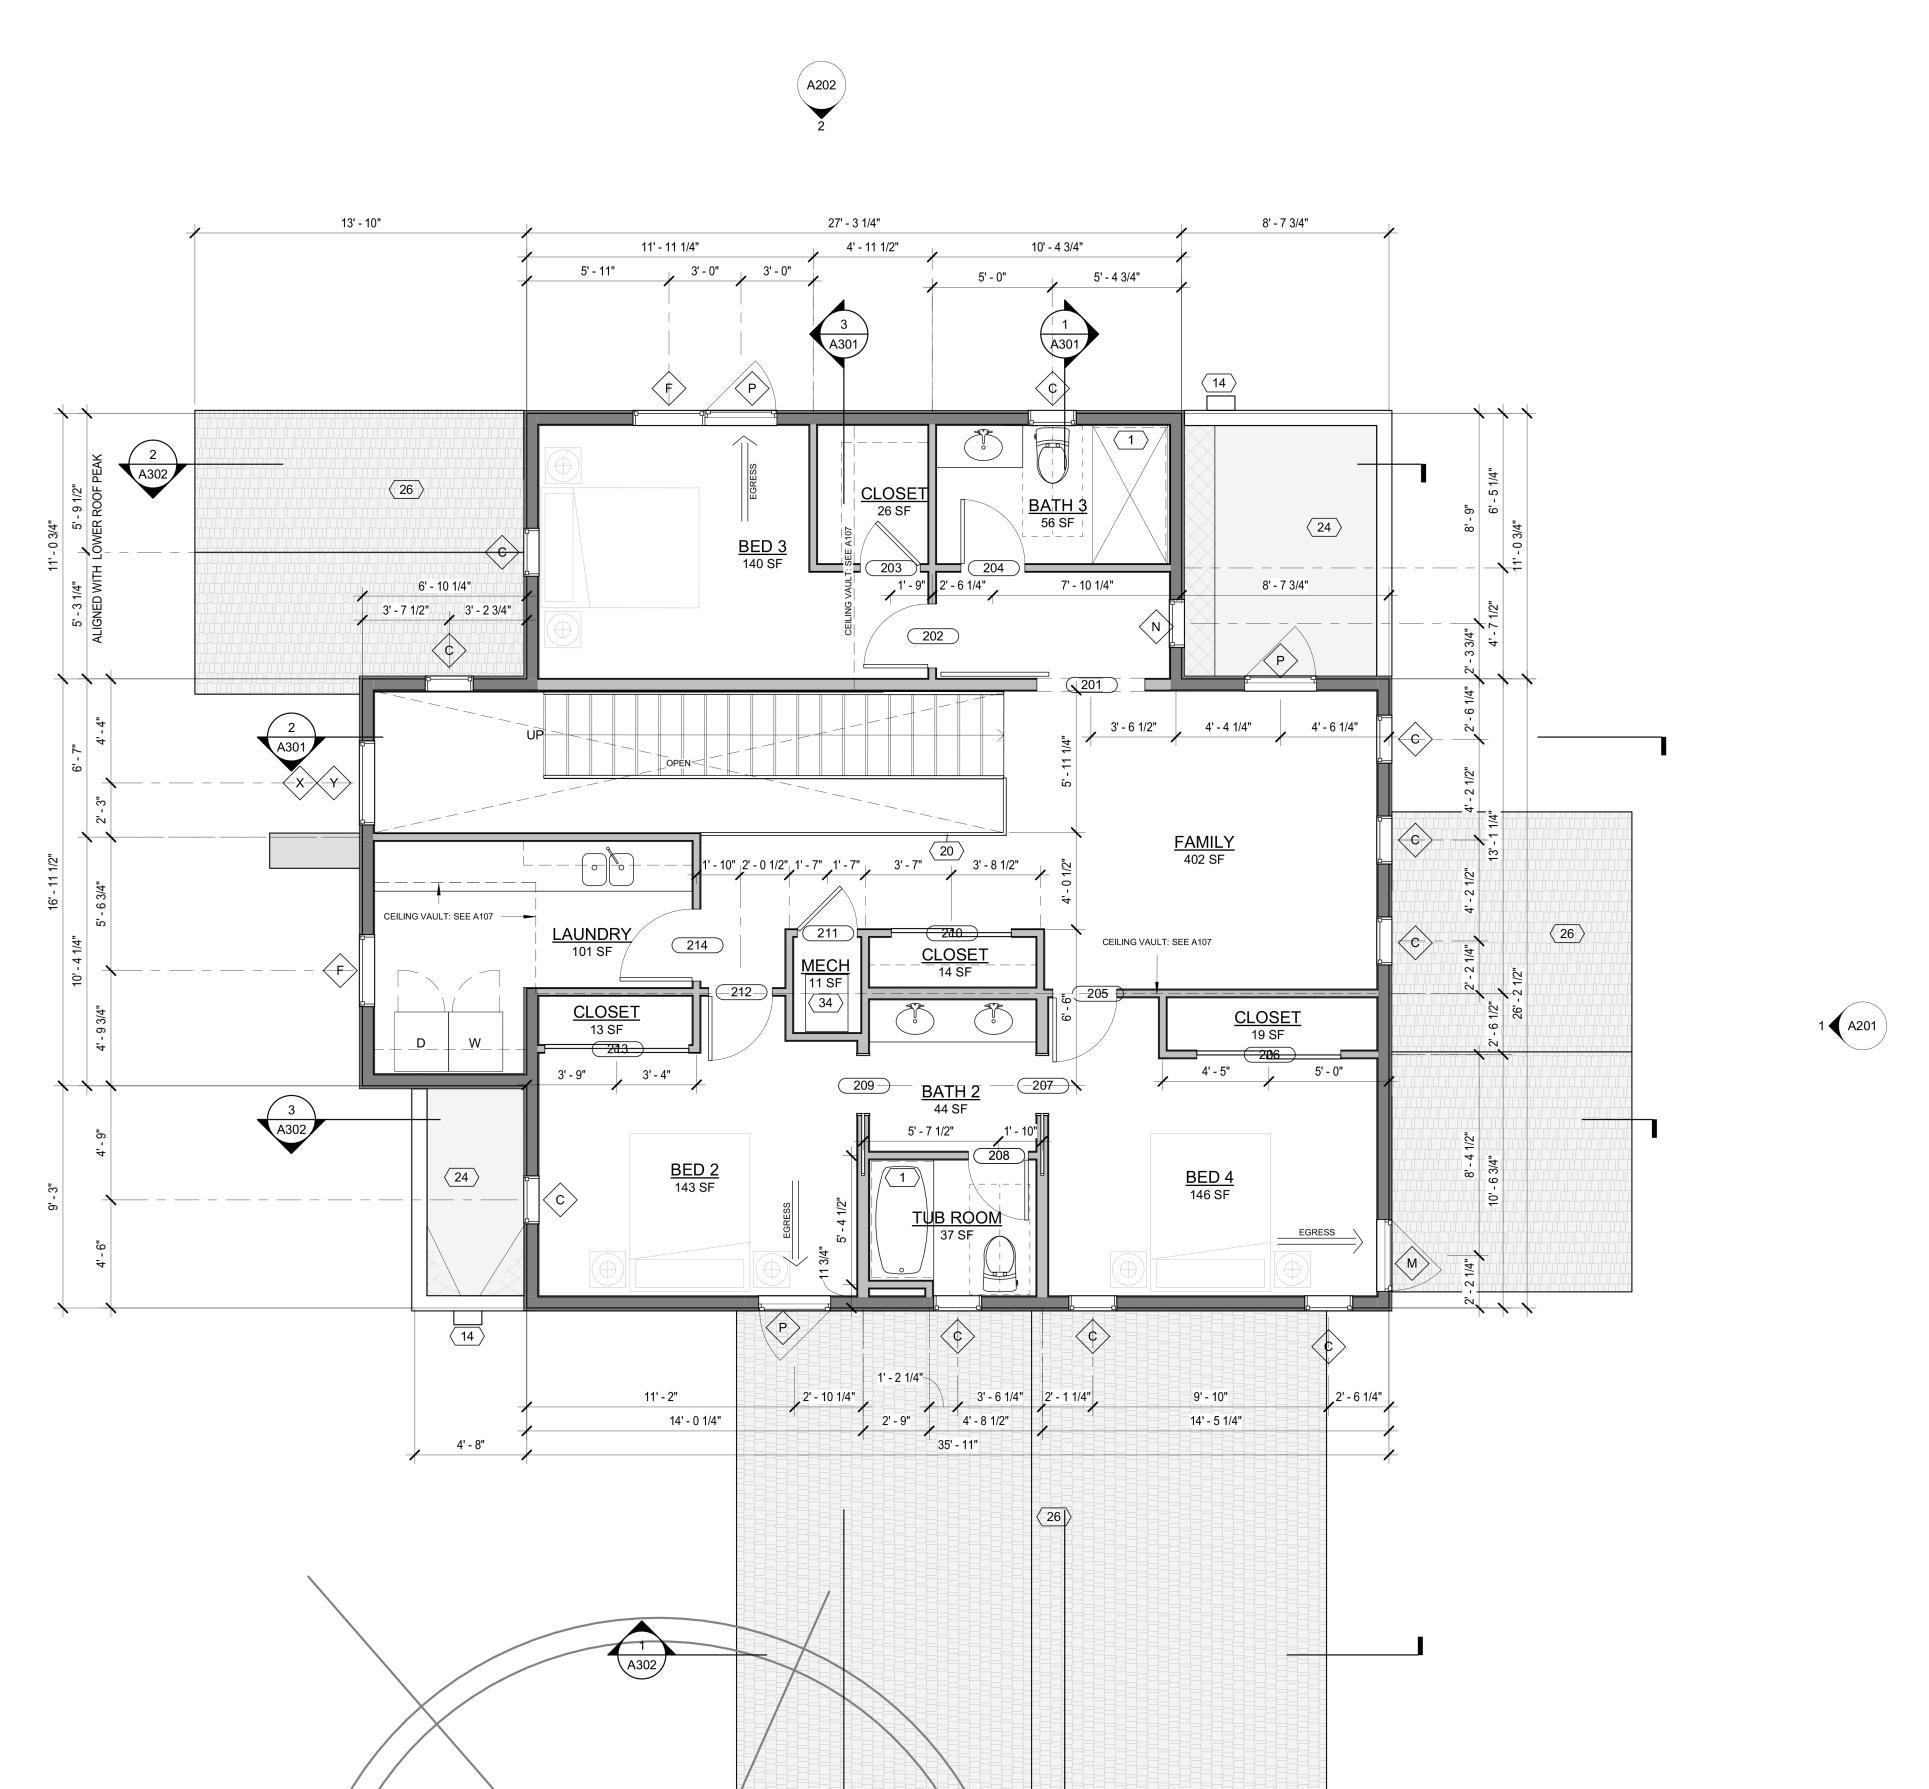

(E)/

1.GAS LINES:

GAS PIPING PLACED UNDER ANY CONCRETE SLAB SHALL COMPLY PER UPC 1210.1.6. REQUIREMENTS. SHALL CONFORM TO U.P.C. CHAPTER 12 FOR MATERIALS, INSTALLATION, AND TESTING.

GENERAL NOTES:

FLOOR PLAN

2. RANGES AND COOKTOPS: Provide a listed and approved range and/or cooktop unit installed in accordance with the listing and with the manufacturer's

instructions. 3. VERIFY AND MAINTAIN REQUIRED HORIZONTAL AND VERTICAL CLEARANCES ABOVE THE FINISHED COUNTERTOP SURFACE BEFORE ORDERING OR INSTALLING CABINETS.

4. MAXIMUM STUD SPACING IS 16 INCHES ON CENTER UNLESS NOTED OTHERWISE


5. REFER TO STRUCTURAL DRAWINGS FOR LOCATIONS AND ADDITIONAL REQUIREMENTS FOR LOAD-BEARING


AND SHEAR WALLS


6. TYPICAL GYPSUM SHEATHING THICKNESS IS 5/8 INCH UNLESS NOTED OTHERWISE


7. SEE DETAIL 9 ON A110 FOR STUCCO SYSTEM ASSEMBLY

FLOOR PLAN LEGEND

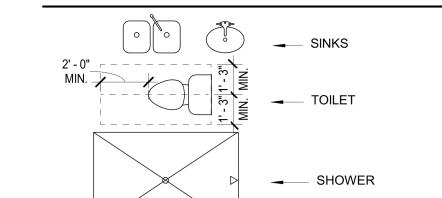

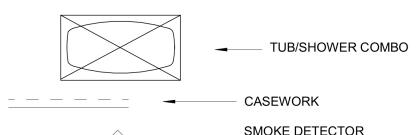

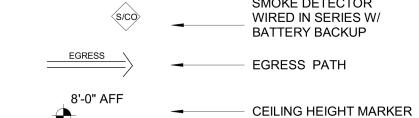

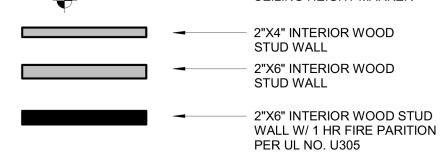

2"X6" EXTERIOR WOOD



90% OF LAMPS IN PERMANENT FIXTURES OR 90% OF PERMANENT FIXTURES HAVE HIGH EFFICACY LAMPS. DOES NOT APPLY TO LOW VOLTAGE LIGHTING

KEYNOTES

- **14** ROOF SCUPPER
- 20 36 MIN. HEIGHT GAURDRAIL W/ 4 MAX VERTICAL SPACING OF HORIZONTIAL RUNGS. GAURDRAIL TO SUPPORT 200# CONCENTRATED LOAD / 50# UNIFORM LOAD
- **24** FOAM ROOF PER ICC-ESR REPORT
- ESR-2532 **26** ASPHALT SHINGLE ROOF PER ICC-ESR
- **REPORT ESR-1475 34** AIR HANDLER, SEE MECH.

